



STATE OF MAINE
DEPARTMENT OF TRANSPORTATION
16 STATE HOUSE STATION
AUGUSTA, MAINE
04333-0016

JOHN ELIAS BALDACCI
GOVERNOR

DAVID A. COLE
COMMISSIONER

July 17, 2007
Subject: **Windham**
Project No. STP-1335(500)X
Pin No. 13355.00
Amendment No. 3

Dear Sir/Ms:

Please make the following changes to the Bid Documents:

In the Bid Book, within the: "Schedule of Items" dated 070625 on page three of four under Item 635.31, "Prefab Concrete Block Gravity Wall" DELETE the existing quantity of 4298.000 SF and REPLACE with the following quantity: 4750.000 SF. Make this change in pen and ink.

In the Plan Sheets, ADD the attached plans sheets: Wall Elevation Sheets E1, E2, E3 and E4.

The following question has been received.

Question: Is the method of measurement based on MaineDOT plans or working plans submitted by the supplier.

Response: See Special Provision 635, Prefabricated Gravity Retaining Wall (Prefabricated Concrete Block Gravity Wall) Rev. February 2007, Method of Measurement Section, Page 9 of 10.


Consider these changes and information prior to submitting your bid on July 18, 2007.

Sincerely,

Scott Bickford
Contracts & Specifications Engineer



PRINTED ON RECYCLED PAPER

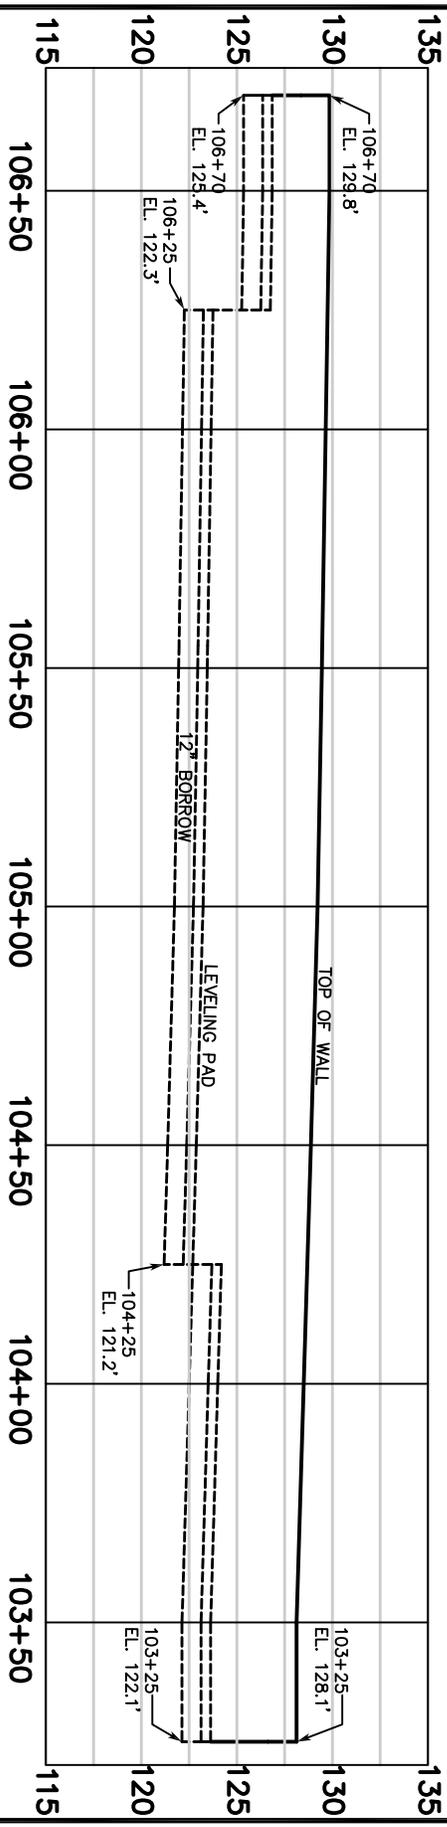


WALL STATION 103+25 ~ 106+70

THIS PLAN REPRESENTS THE WALL SECTIONS BASED ON THE PATH CROSS SECTIONS AND DOES NOT REPRESENT AN ACTUAL WALL DESIGN. THE ACTUAL DESIGN TO BE PROVIDED BY THE MANUFACTURER AND APPROVED BY MDOT PRIOR TO CONSTRUCTION.

FILE NAME: Elev1

<table border="1"> <tr> <td>SCALE</td> <td>MDOT</td> </tr> <tr> <td>H=1"=40'</td> <td>DESIGNED</td> </tr> <tr> <td>V=1"=10'</td> <td>DAW</td> </tr> </table>	SCALE	MDOT	H=1"=40'	DESIGNED	V=1"=10'	DAW		<table border="1"> <tr> <td>DATE</td> <td>7/16/07</td> </tr> <tr> <td>DRAWING NO.</td> <td>E1</td> </tr> </table>	DATE	7/16/07	DRAWING NO.	E1
SCALE	MDOT											
H=1"=40'	DESIGNED											
V=1"=10'	DAW											
DATE	7/16/07											
DRAWING NO.	E1											
<table border="1"> <tr> <td>CHECKED</td> <td>DRAIN</td> </tr> <tr> <td>DAW</td> <td>NPN</td> </tr> </table>	CHECKED	DRAIN	DAW	NPN	SUMMIT ENGINEERING, INC <small>Engineers • Surveyors • Planners • Landscape Architects</small>	<table border="1"> <tr> <td>PROJECT NO.</td> <td>7510.05</td> </tr> </table>	PROJECT NO.	7510.05				
CHECKED	DRAIN											
DAW	NPN											
PROJECT NO.	7510.05											
WALL ELEVATION		MOUNTAIN DIVISION RAIL TRAIL ROUTE 202 TO GAMBO ROAD WINDHAM, MAINE										
50 Joy Drive South Burlington, VT 05403 Bus. (802) 658-5588 Fax (802) 658-3629												

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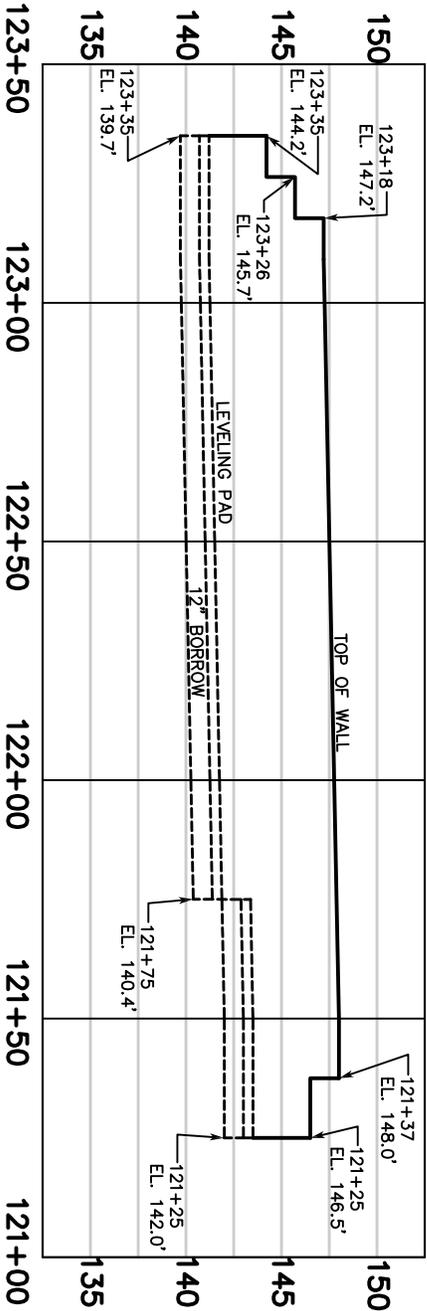


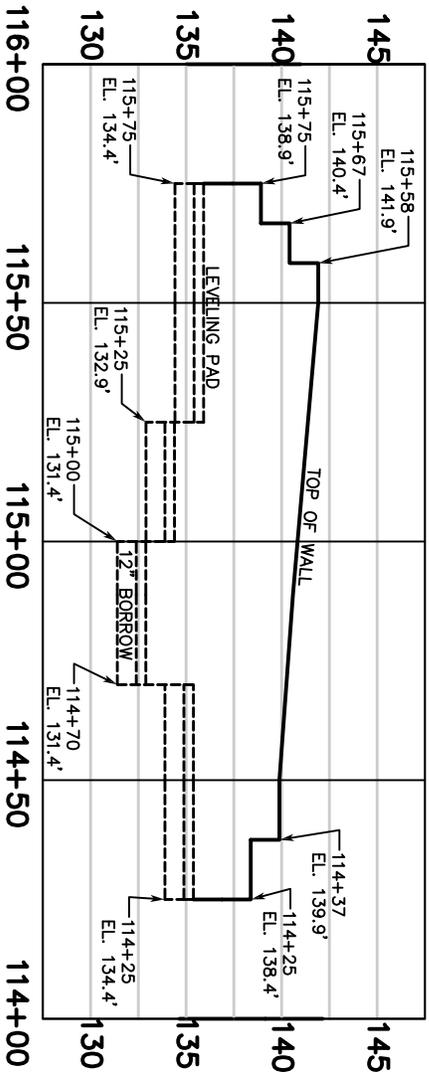WALL STATION 114+25 ~ 115+75

<table border="1"> <tr> <td>DESIGNED</td> <td>MDOT</td> </tr> <tr> <td>CHECKED</td> <td>DAW</td> </tr> <tr> <td>DRAWN</td> <td>NPN</td> </tr> <tr> <td>SCALE</td> <td>DAW</td> </tr> <tr> <td>H=1"=40'</td> <td></td> </tr> <tr> <td>V=1"=10'</td> <td></td> </tr> </table>	DESIGNED	MDOT	CHECKED	DAW	DRAWN	NPN	SCALE	DAW	H=1"=40'		V=1"=10'			<p>SUMMIT ENGINEERING, INC Engineers + Surveyors + Planners + Landscape Architects</p> <p>50 Joy Drive South Burlington, VT 05403 Bus. (802) 658-5588 Fax (802) 658-3629</p>	<p>WALL ELEVATION</p>	<p>DATE 7/16/07</p>
DESIGNED	MDOT															
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SCALE	DAW															
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<p>MOUNTAIN DIVISION RAIL TRAIL ROUTE 202 TO GAMBO ROAD WINDHAM, MAINE</p>			<p>DRAWING NO. E2</p>	<p>PROJECT NO. 7510.05</p>												

FILE NAME: Elev2

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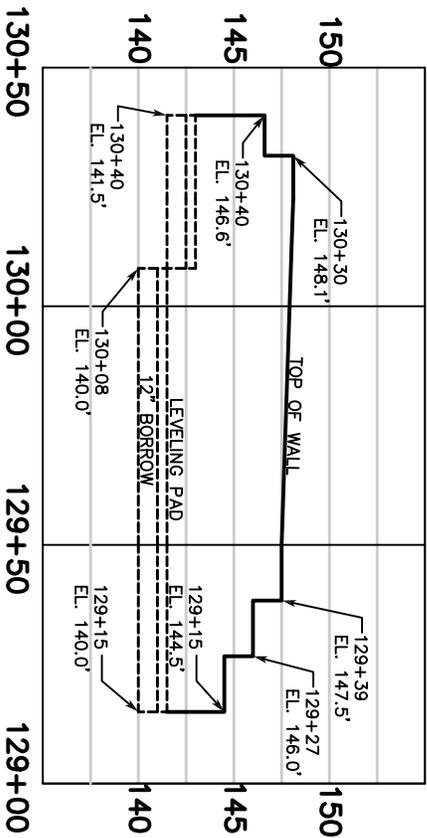
WALL STATION 121+25 ~ 123+35

<table border="1"> <tr> <td>DESIGNED</td> <td>DAW</td> </tr> <tr> <td>CHECKED</td> <td>DAW</td> </tr> </table>	DESIGNED	DAW	CHECKED	DAW		WALL ELEVATION	DATE 7/16/07		
DESIGNED	DAW								
CHECKED	DAW								
<table border="1"> <tr> <td>MDOT</td> <td></td> </tr> <tr> <td>DRAWN</td> <td>NPN</td> </tr> <tr> <td>CHECKED</td> <td>DAW</td> </tr> </table>	MDOT		DRAWN	NPN	CHECKED	DAW	SUMMIT ENGINEERING, INC <small>Engineers + Surveyors + Planners + Landscape Architects</small>	MOUNTAIN DIVISION RAIL TRAIL ROUTE 202 TO GAMBO ROAD WINDHAM, MAINE	PROJECT NO. 7510.05
MDOT									
DRAWN	NPN								
CHECKED	DAW								

FILE NAME: Ebor3

SCALE: H=1"=40'
V=1"=10'

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WALL STATION 129+15 ~ 130+40

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SCALE	DESIGNED	DATE														
H 1"=40'	DAW	7/16/07														
V 1"=10'																
DATE	PROJECT NO.															
7/16/07	E4 7510.05															

FILE NAME: Elev4